





7 TYPICAL E & F WING CUTRAIN WALL SECTION
SCALE: 3/4" = 1'-0"

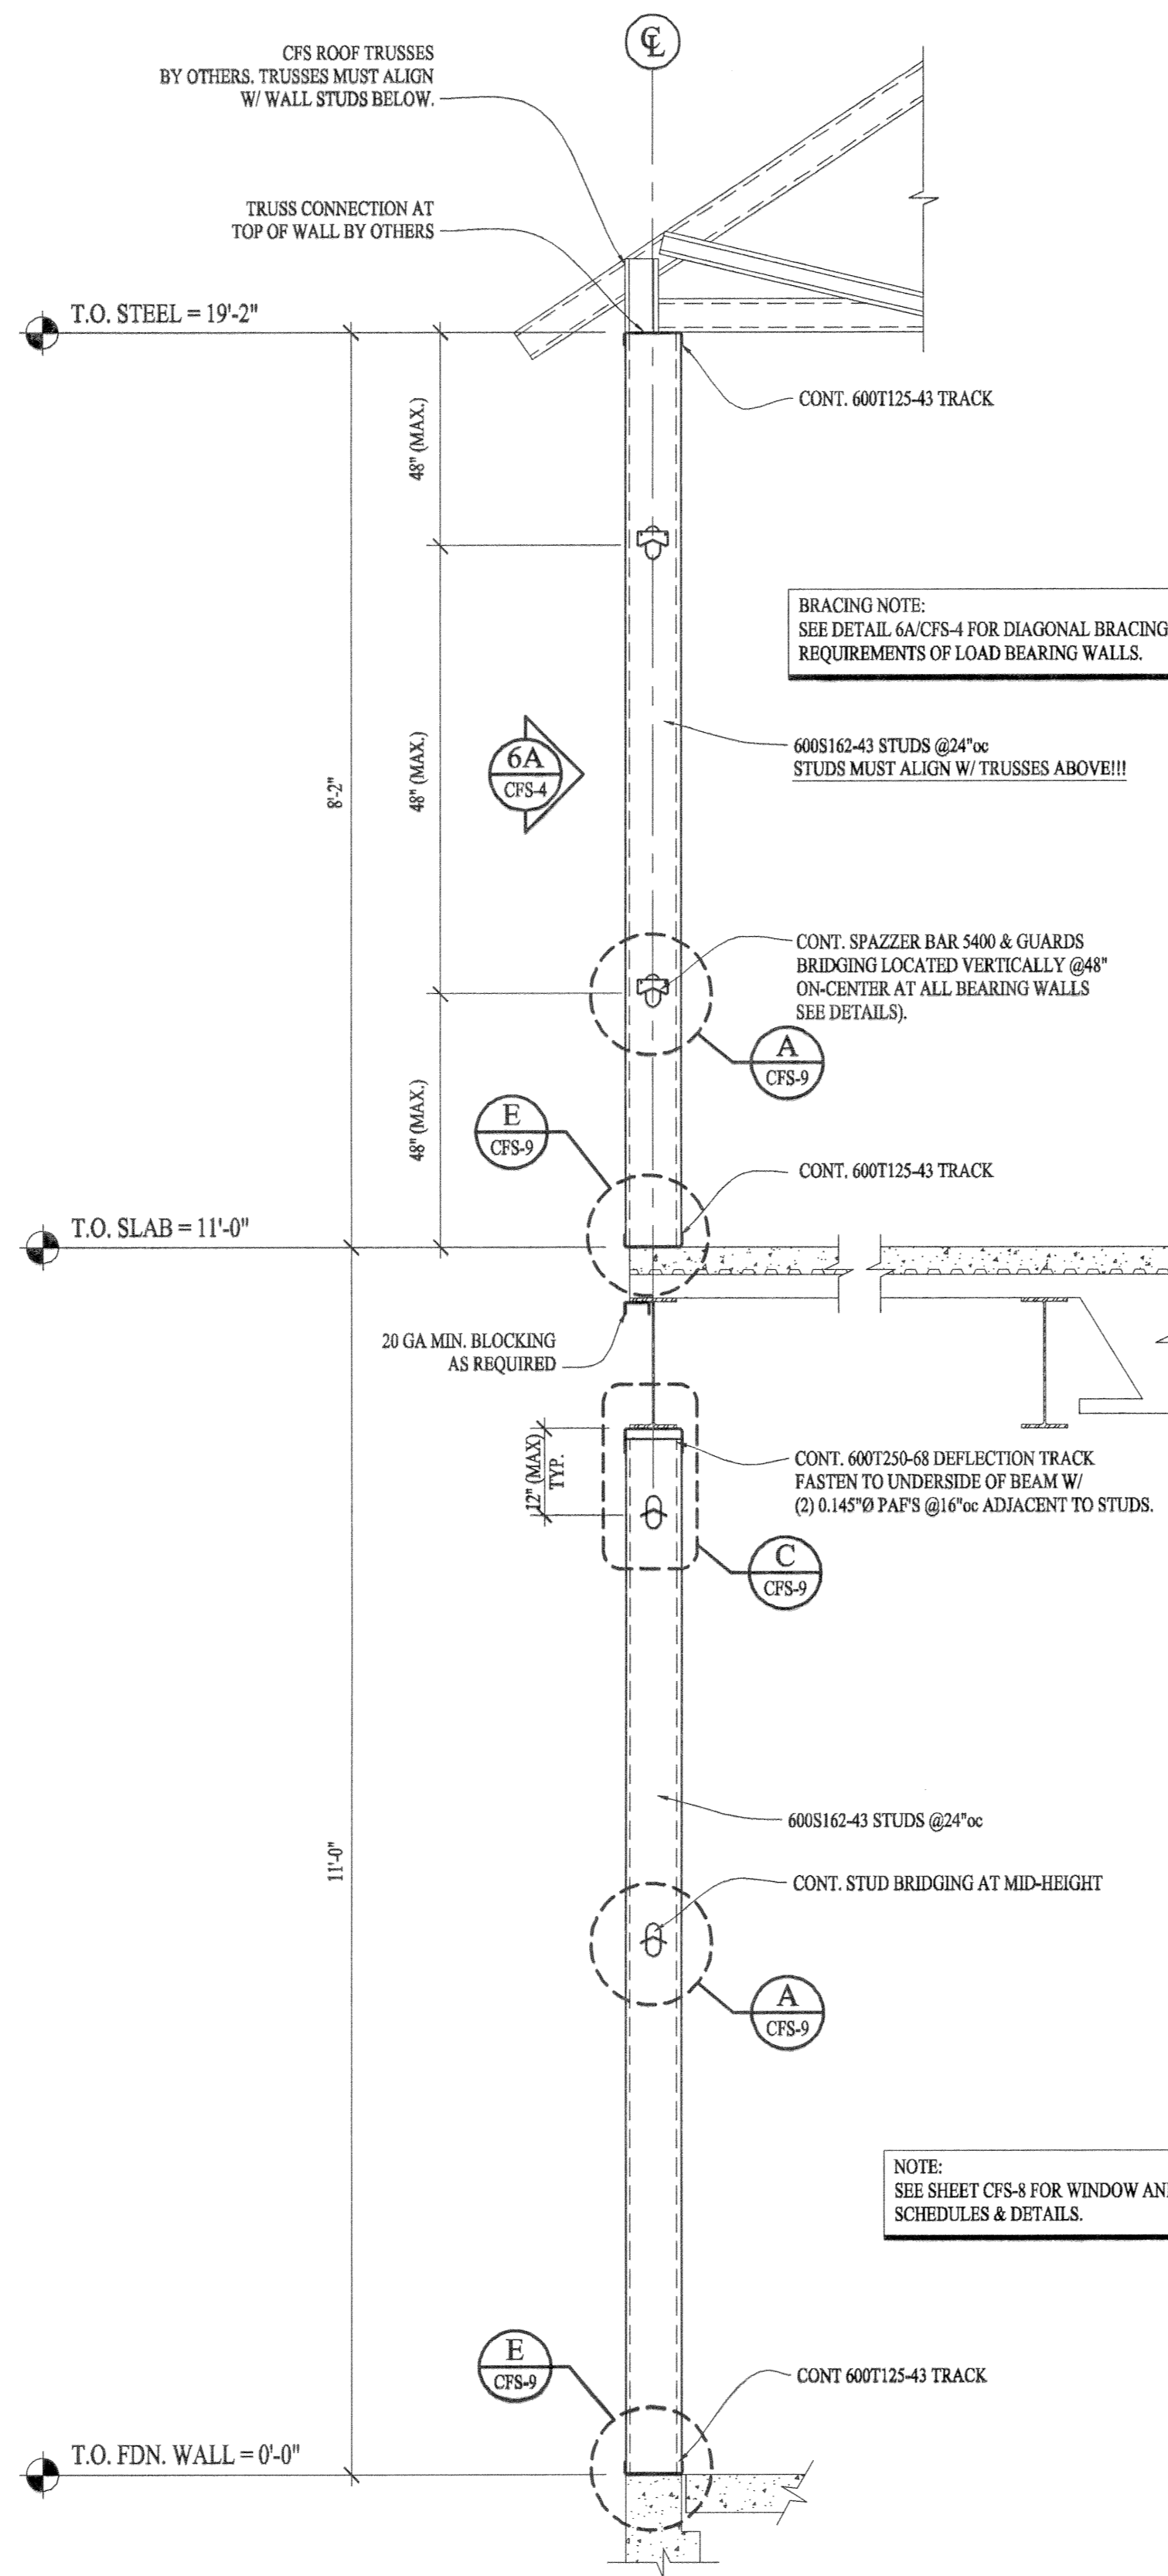

8 TYPICAL LOAD BEARING WALL SECTION AT F WING
SCALE: 3/4" = 1'-0"

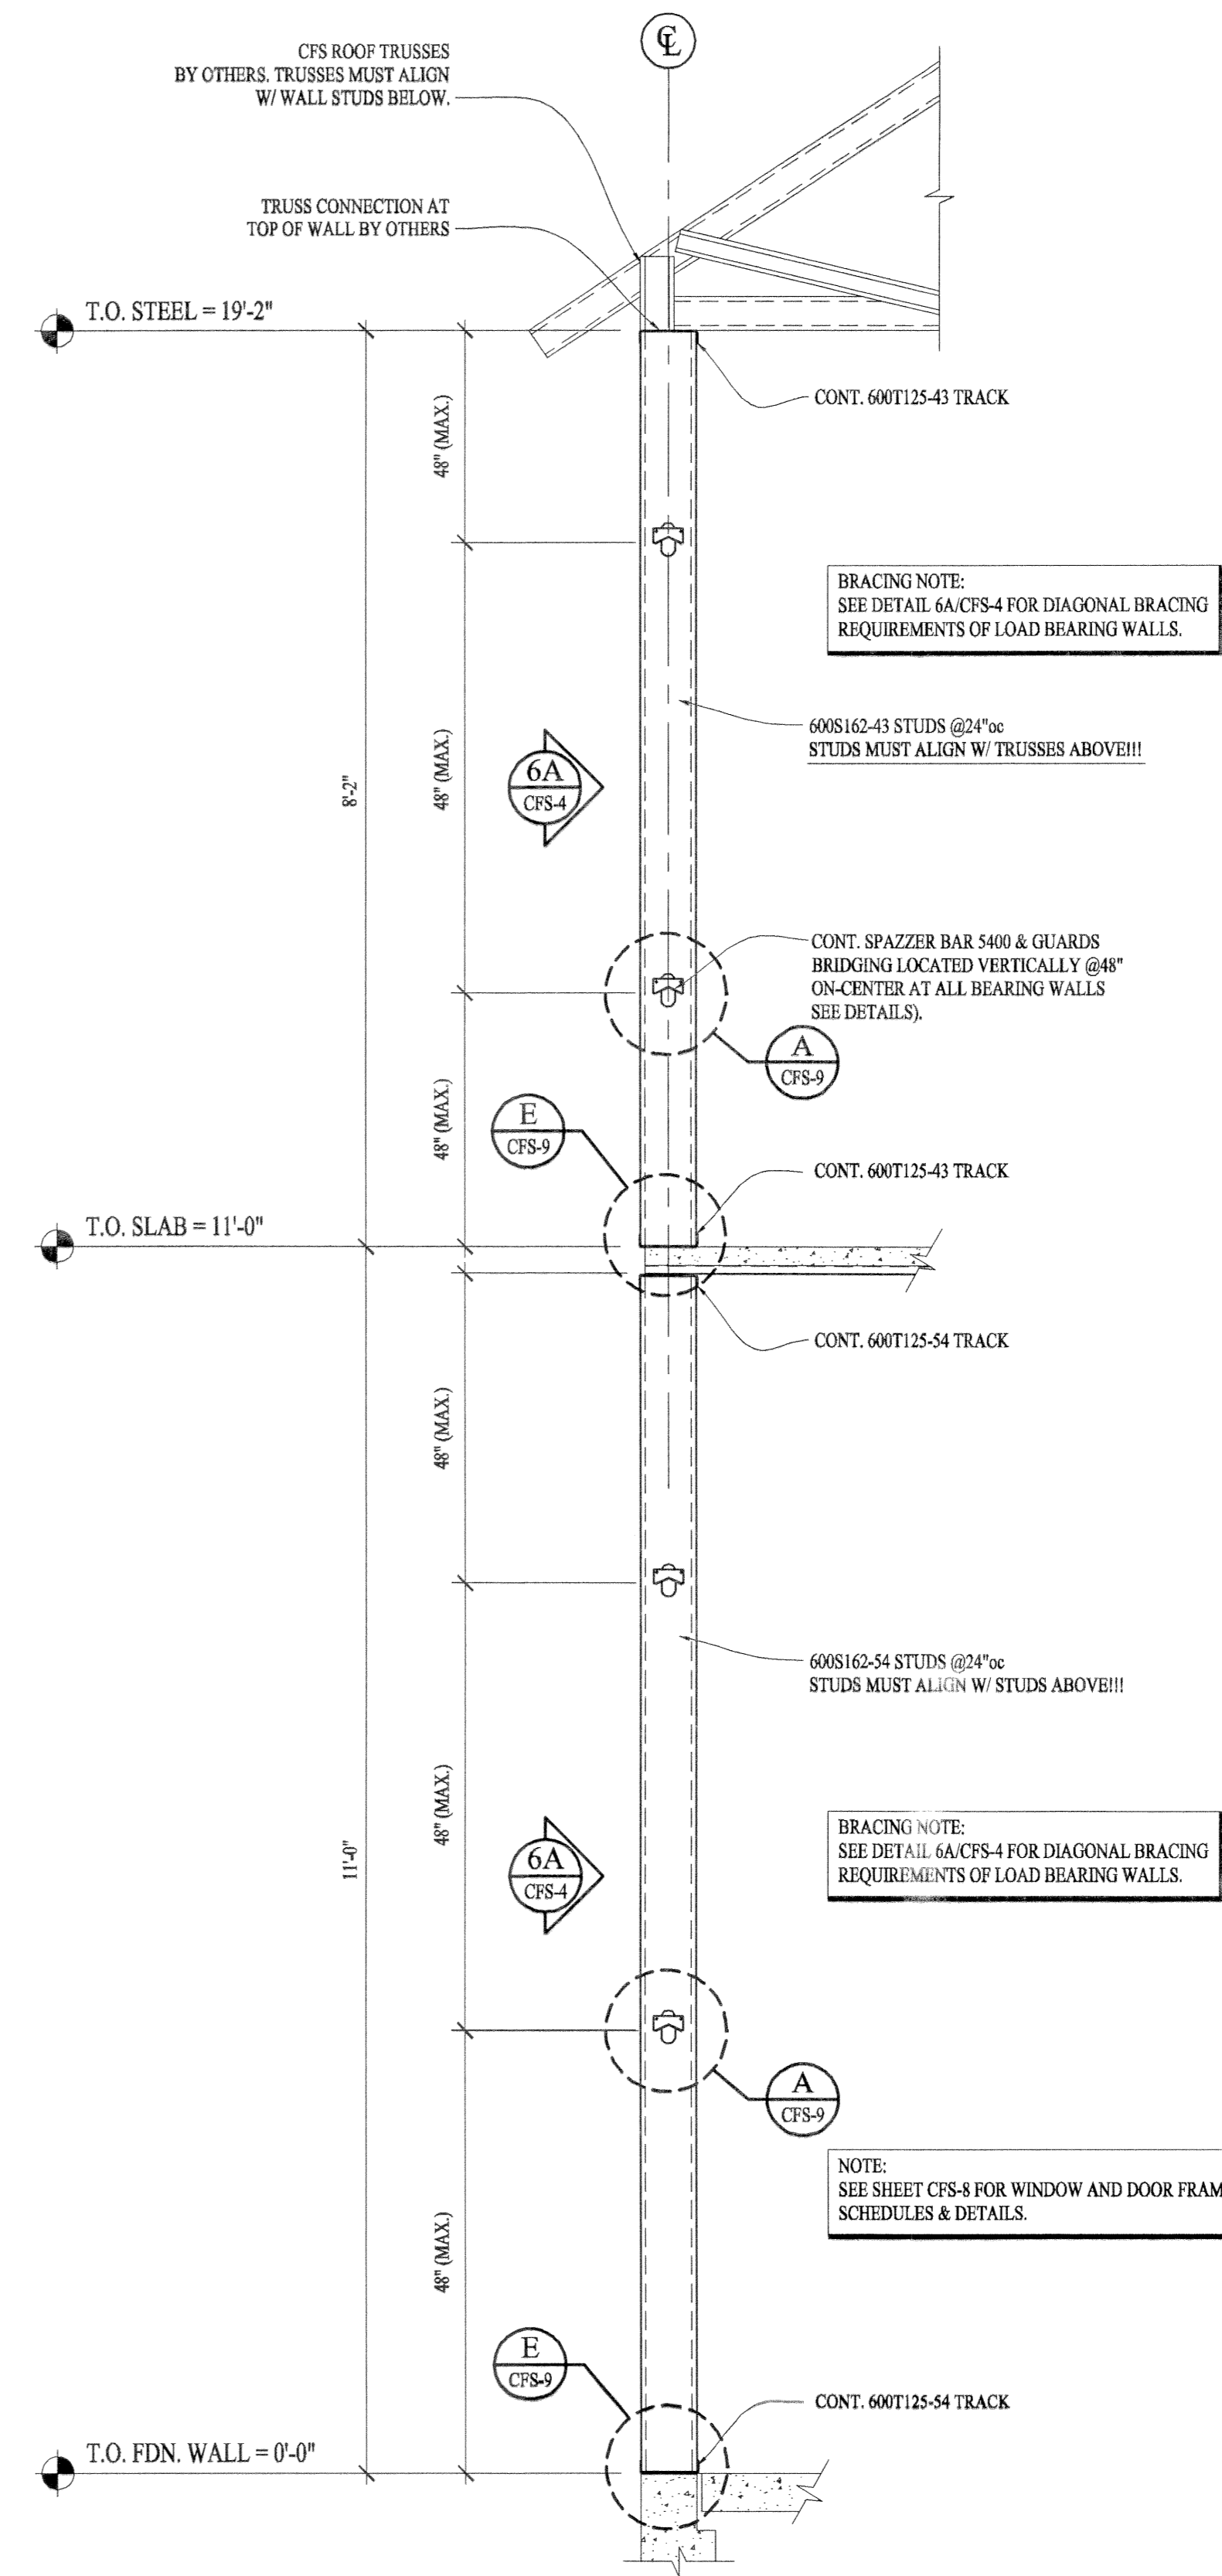

9 TYPICAL LOAD BEARING WALL SECTION AT E WING
SCALE: 3/4" = 1'-0"

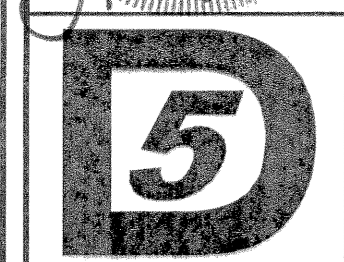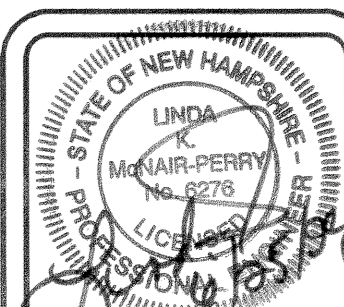

D5 COLD FORMED STEEL
DESIGN CONSULTANTS, LLC.
52 DANE ROAD
NEW BOSTON, NH 03070
(603) 714-1557

- General Notes
1. THESE DRAWINGS SHALL BE USED IN CONJUNCTION WITH THE REFERENCE PROJECT ONLY.
 2. DO NOT SCALE DRAWINGS.
 3. ALL DIMENSIONS AND CONDITIONS SHALL BE VERIFIED BY THE CONTRACTOR. ANY DISCREPANCIES SHALL BE BROUGHT TO THE ATTENTION OF THE DESIGNER PRIOR TO THE COMMENCEMENT OF WORK.
 4. THE CONTRACTOR IS RESPONSIBLE FOR THE SUPPLY OF SPECIFIED MATERIALS MEETING THE SPECIFICATIONS SHOWN ON THESE DRAWINGS AND AS INDICATED IN CALCULATIONS.
 5. THE CONTRACTOR SHALL FOLLOW MANUFACTURER'S INSTRUCTIONS FOR HANDLING, STORAGE, & INSTALLATION OF ALL MATERIALS, ACCESSORIES, AND FASTENERS.

1	SER. COMMENTS	GEN. CLARIFICATION	DATE
No.	Revision/Issue		Day

Sheet Title:

SECTIONS & DETAILS

Customer:
METRO WALLS, INC.
49 Hancock Street
Manchester, NH 03101
Ph: (603) 668-2648
F: (603) 668-2542

Project Name:
The Boulders
Exeter, NH

Project: 09010
Date: 02/02/09
Scale: AS NOTED
Sheet: CFS-5